
1. THIS DRAWING IS TO BE READ IN CONJUNCTION WITH ALL ARCHITECTURAL DRAWINGS

2. THIS DRAWING IS TO BE READ IN CONJUNCTION WITH THE SPECIFICATION.

3. ALL DIMENSIONS ARE IN MILLIMETRES UNLESS OTHERWISE STATED. LEVELS ARE IN METRES A.O.D.

BY THE CONTRACTOR/FABRICATOR PRIOR TO COMMENCEMENT OF ANY WORK.

4. ALL DIMENSIONS ARE TO BE CHECKED ON SITE

5. DO NOT SCALE: CONTRACTOR TO CHECK ALL DIMENSIONS, DRAWING SUBJECT TO DETAIL DESIGN.

THIS DRAWING IS INDICATIVE AND FOR DESIGN INTENT PURPOSES.

ALL LEVELS ARE INDICATIVE AND SUBJECT TO DETAIL DESIGN AND FINAL CONFIRMATION.

ALL DIMENSIONS AND LEVELS ARE TO BE CHECKED ON SITE.

ANY DISCREPANCIES TO BE REPORTED TO THE ARCHITECT PRIOR TO ANY WORK COMMENCING.

THIS DRAWING SHALL NOT BE SCALED TO

ASCERTAIN DIMENSIONS, CONTRACTOR/ SUB-CONTRACTOR SHALL

CHECK ALL DIMENSIONS AND REPORT ANY ANOMALIES AND/ OR OMMISIONS OR ERRORS.

DIMENSIONS INDICATED ARE IN MILLIMETRES UNLESS OTHERWISE STATED.

IN ADDITION TO OTHER RELEVANT ARCHITECTURAL DRAWINGS AND SPECIFICATIONS, THIS DRAWING IS TO BE READ IN CONJUNCTION WITH THE FOLLOWING DRAWINGS AND DOCUMENTS:

ALL RELEVANT STRUCTURAL ENGINEER'S SPECIFICATION AND DRAWINGS AS APPLICABLE, FOR ALL SUB-STRUCTURE AND SUPER-STRUCTURE WORKS/ REQUIREMENTS.

ALL RELEVANT M & E SERVICES ENGINEER'S SPECIFICATIONS AND DRAWINGS AS APPLICABLE, FOR ALL MECHANICAL AND ELECTRICAL SERVICES WORKS/ REQUIREMENTS.

STRUCTURAL REQUIREMENTS

ALL AND ANY STRUCTURAL ALTERATIONS TO STRUCTURAL ENGINEERS DETAIL / DESIGN, TO LOCAL AUTHORITY BY STRUCTURAL ENGINEER, 28 DAYS MINIMUM BEFORE WORK COMMENCES ON SITE.

ALL STRUCTURAL CALCULATIONS AND DETAILS, TO BE SUBMITTED FOR APPROVAL TO LOCAL AUTHORITY BY STRUCTURAL ENGINEER, 28 DAYS MINIMUM BEFORE WORK COMMENCES ON SITE.

ALL EXISTING DRAINAGE RUNS AND CONNECTIONS TO BE CHECKED ON SITE PRIOR TO THE COMMENCEMENT OF WORK

ALL EXISTING DRAINS AND GULLIES THROUGHOUT THE PROPERTY TO BE JET CLEANED UPON COMPLETION OF THE WORKS

MAIN DRAINAGE RUNS SHOWN TOGETHER WITH INSPECTION CHAMBERS AND RODDING EYES ARE INDICATIVE ONLY, CONTRACTOR TO LOCATE EXISTING DRAINAGE RUNS PRIOR TO THE COMMENCEMENT OF WORK.

ALL EXPOSED REVEALS TO HAVE A NEW PLASTER FINISH, ALL AREAS MADE GOOD UPON COMPLETION

SD INDICATES LOCATION OF SMOKE DETECTOR

(HD) INDICATES LOCATION OF HEAT DETECTOR

INDICATES CEILING MOUNTED EXTRACT FAN CAPABLE
OF PROVIDING A MIN. EXTRACT RATE OF 15 LITRES
PER SECOND TO THE WC
EXTRACT FANS TO BE WIRED UP THE LIGHT SWITCH
WITH A 15 MIUTE OVER RUN.
FAN IS TO BE DUCTED THRO' THE ROOF VOID TO A
PROPRIETARY TILE VENT. CONTRACTOR TO ENSURE
THAT A PROPRIETARY CONDENSATION TRAP IS FORMED
WITHIN THE DUCT WORK WITH A DRAIN RUNNING
AND DISCHARGING INTO THE GUTTERS.

INTERNAL AND EXTERNAL LIGHTING TO BE IN ACCORDANCE WITH PART L1 OF THE APPROVED DOCUMENT.

ALL GLAZING IN CRITICAL LOCATIONS TO COMPLY WITH PART NOF THE APPROVED DOCUMENT.

ALL NEW LINTOLS INDICATED TO BE POSITIONED AS HIGH AS POSSIBLE TO MINIMISE DOWNSTANDS IN NEW CEILINGS


ALL BEAMS INDICATED TO BE ENCASED IN 15mm THICK FIRELINE BOARD TO PROVIDE 1 HOUR FIRE RESISTANCE ALL SUPPLIED BY BRITISH GYPSUM AND INSTALLED IN ACCORDANCE WITH THEIR PRINTED INSTRUCTIONS. ALL JOINTS TO BE TAPED AND PLASTERBOARD TO HAVE A SKIM FINISH.


ALL NEW WINDOWS TO BEDROOMS TO HAVE A MIN 450x750mm OPENING LIGHT FOR MEANS OF ESCAPE PURPOSES TO COMPLY WITH PART B OF THE APPROVED DOCUMENT. CILL HEIGHT OF OF WINDOWS TO BE A MIN. 800mm ABOVE F.F.L.

ALL EXISTING TILES WHICH CAN BE REUSED ARE TO BE CAREFULLY TAKEN DOWN AND STORED IN A SECURE PLACE ON SITE PRIOR TO REUSE

ALL LINTOLS INDICATED TO BE ENCASED IN 15mm THICK FIRELINE BOARD TO PROVIDE 1 HOUR FIRE RESISTANCE ALL SUPPLIED BY BRITISH GYPSUM AND INSTALLED IN ACCORDANCE WITH THEIR PRINTED INSTRUCTIONS. ALL JOINTS TO BE TAPED AND PLASTERBOARD TO HAVE A SKIM FINISH.

PROVIDE MAINS WIRED AND INTERLINKED SMOKE
DETECTION TO THE GROUND FLOOR HALL AND FIRST
FLOOR LANDING CEILINGS WITHIN THE STAIRCASE AREA
RADIATOR LOCATIONS SHOWN ARE INDICATIVE
FINAL LOCATIONS TO BE CONFIRMED ON
SITE BY THE CLIENT

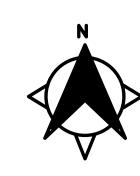

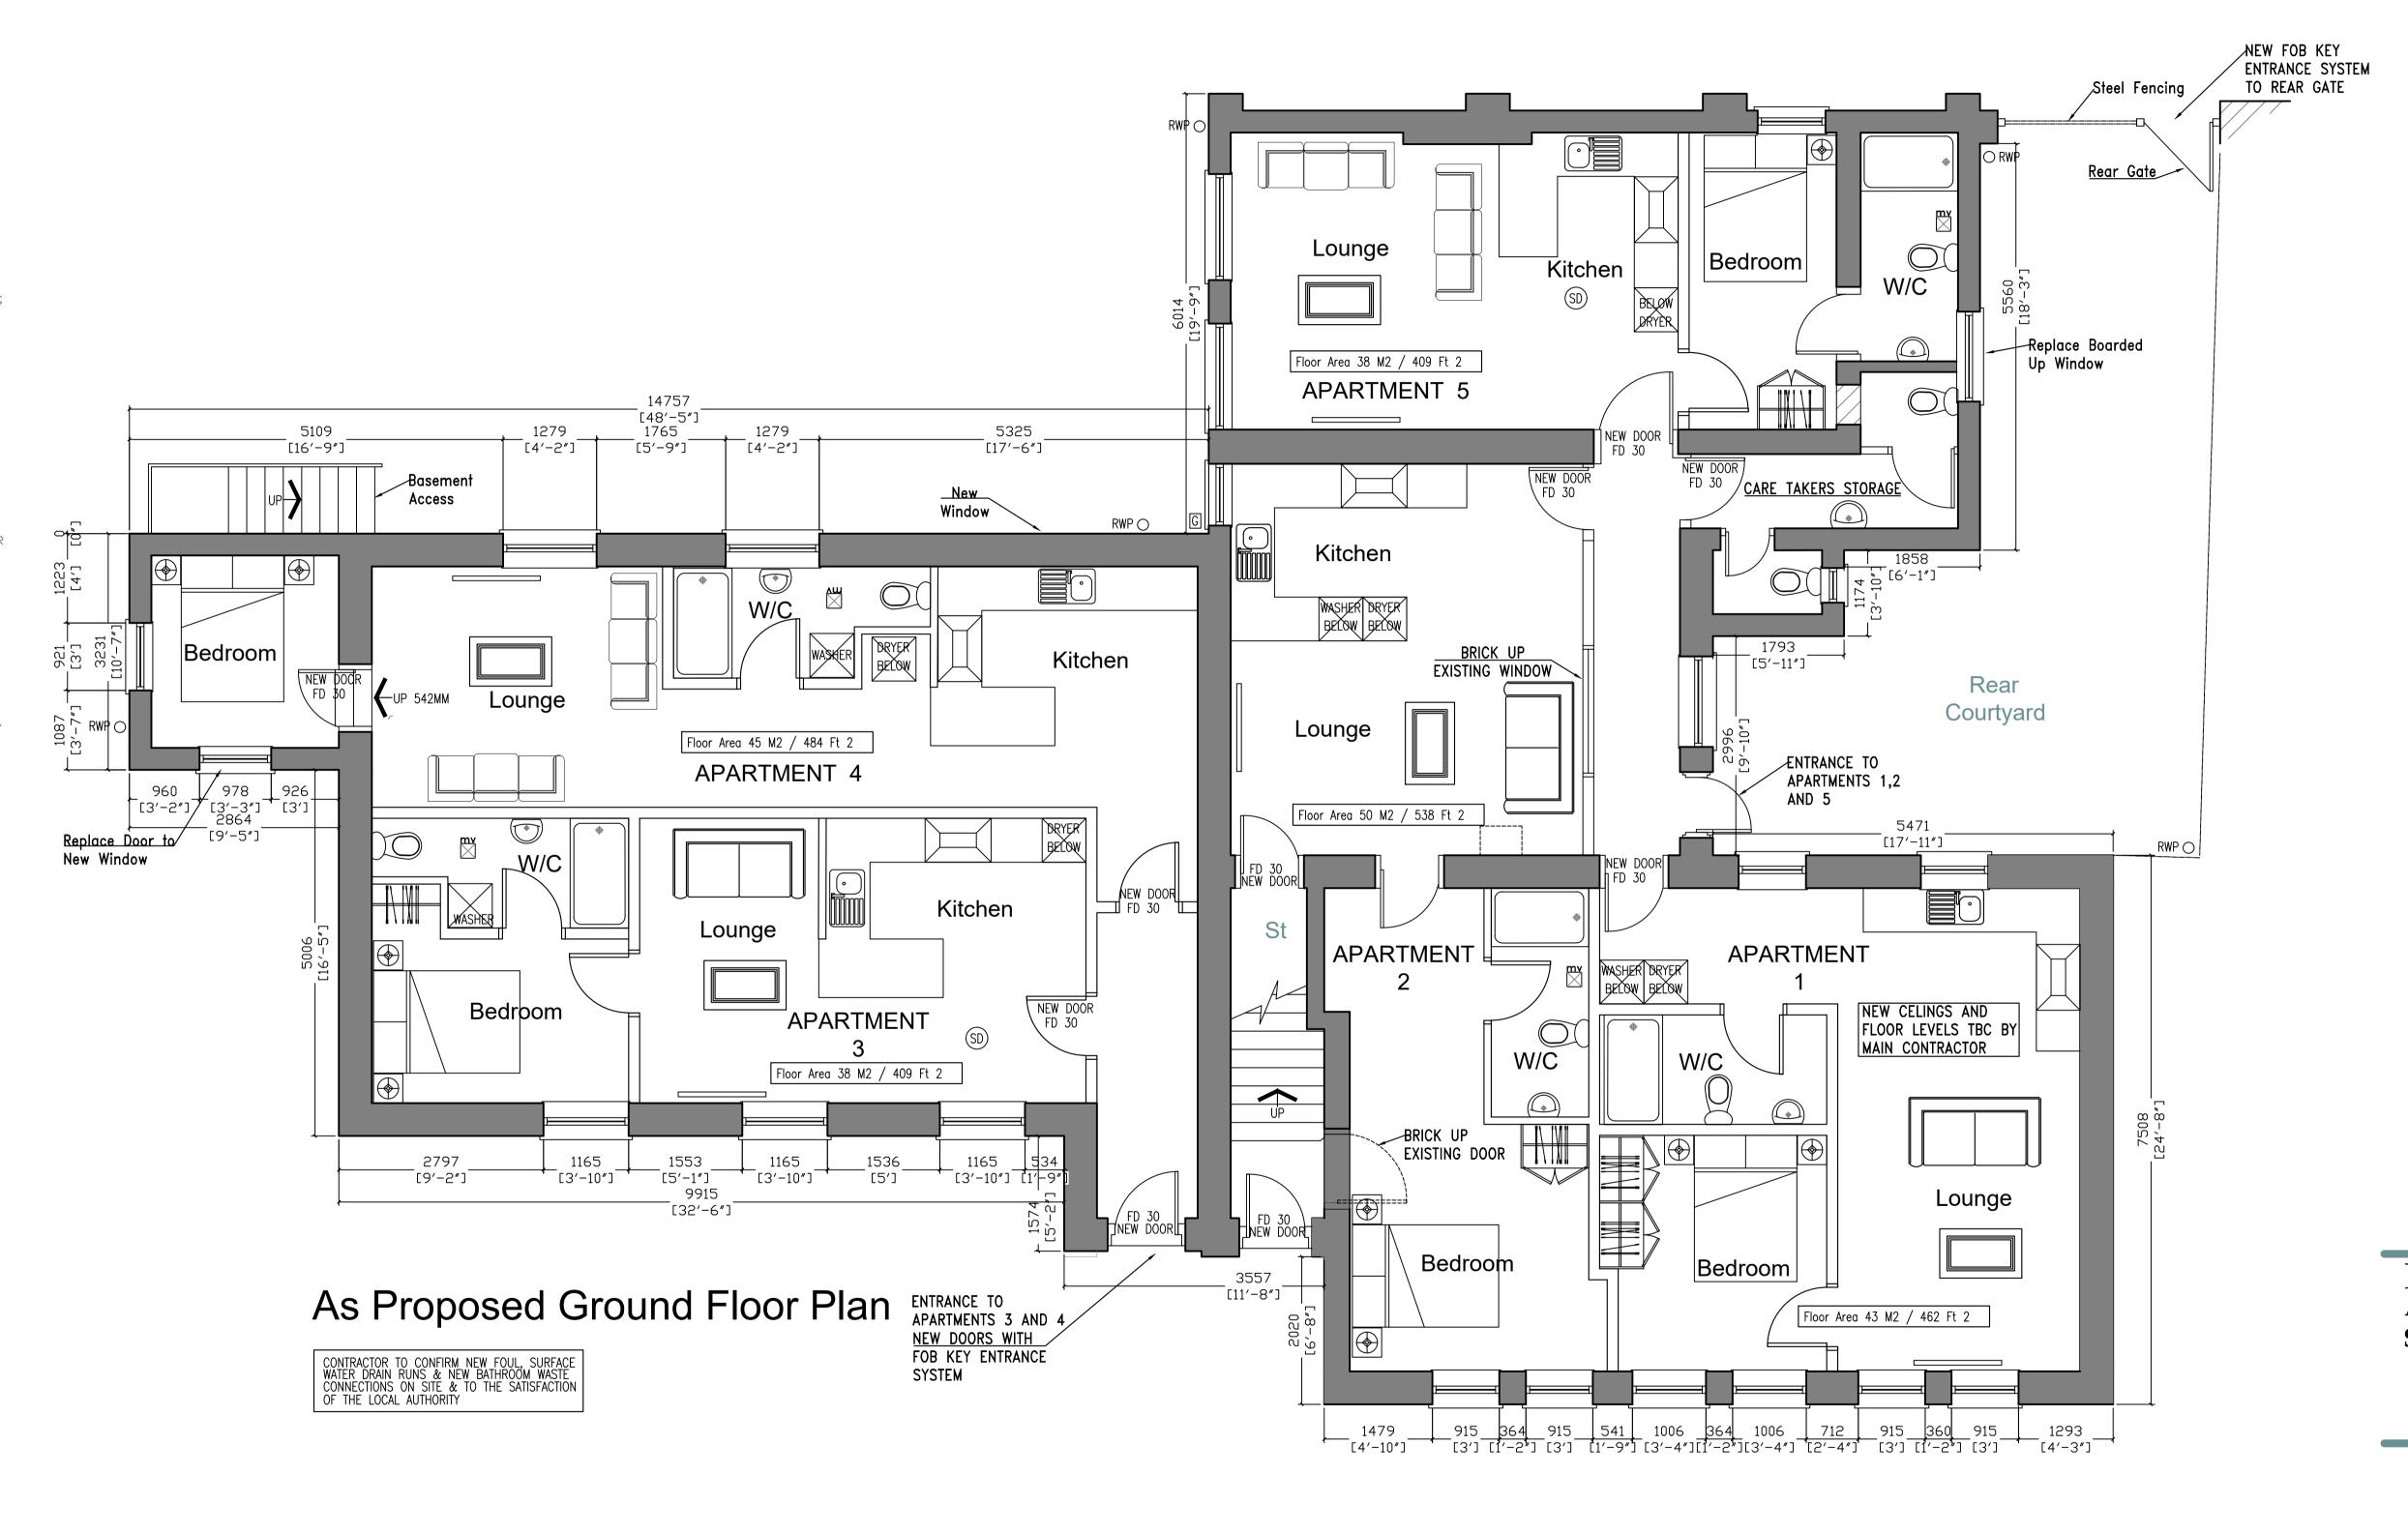

PLANNING

H.F.S Architectural Services

Client:
Sal Developments

Project Title:Unitarian Chapel Hindley

Drawing Title

As Proposed Ground Floor Plan

DWG No.

Drawn By: FiT

Drawn By: FiT Scale: 1:50 on A1 Checked, Confirmed Date: 01/08/22

HFS-26-07-07

and Approved By:

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ALL DIMENSIONS ARE IN MILLIMETRES UNLESS STATED OTHERWISE.
THIS DRAWING SHOULD BE READ IN CONJUNCTION WITH ALL OTHER RELEVANT

DRAWINGS AND SPECIFICATIONS, ALL AREAS ARE SUBJECT TO THE SITE SURVEY.